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All dimensions and call-outs to be verified by builder prior to construction. DESIGNER assumes no liability for any structure built from these plans. No changes shall be made without consulting the designer first.

These drawings and the information herein contained are the sole intellectual property of Designer and may not be reproduced in any manner without the company's written consent. These drawings constitute what is normally considered within the construction industry as a "builder set" in as they are intended to convey the design intent only. The implementation of the plans requires a general contractor/subcontractor thoroughly knowledgeable with applicable building codes and methods of construction. The plans are intended to provide basic information regarding site work, electrical, mechanical, plumbing, and other trades to substantially complete construction of the structure. Exact material specifications and selections from agreed "allowances" are to be confirmed with the owner prior to ordering and/or installation.

If provided, contractor/subcontractor to review Owner "image" photos and details and confirm all related details and finishes prior to commencement of construction. Construction means, methods, and materials are solely the jurisdiction of the contractor/subcontractor and are not described in these plans. Exact detailing, structural, mechanical, electrical, waterproofing and flashings are to be determined by the contractor/subcontractor except as noted or described within these drawings. In all cases, the most stringent requirements of all applicable federal, state, county, and local city building, mechanical, electrical, plumbing, and fire codes, laws, ordinances, and regulations must be met. If the contractor/subcontractor or any subcontractor performs any work in conflict with the above mentioned laws, rules, codes, ordinances, and regulations then the contractor/subcontractor in violation shall bear all costs of repair arising out of non-conforming work. All such codes, ordinances, deed restrictions and regulations take precedence over any part of these drawings which may be deficient or in conflict. All plan dimensions and area calculations must be verified by contractor/subcontractor prior to bidding, submittal of proposals or cost estimates or entering into any contracts or subcontracts. All dimensions must be field verified prior to commencement of construction, ordering of materials or fabrication of products. Plan square footages and area calculations indicate on plans are estimates only. Contractor/subcontractor shall do their own area takeoffs and confirm actual square footages. Notify the designer immediately of any discrepancies between plan area calculations and area calculations. DO NOT SCALE FROM DRAWINGS. Contractor/subcontractor shall confirm and verify location of all structures in relation to building lines or setbacks, property lines and easements. Notify the designer immediately with any discrepancies.

GENERAL NOTES:  
PLANS MEET 2021 IRC

- No changes shall be made without consulting the designer first.
- All Bedroom doors to be 1" above carpet and 2" above concrete, unless stained concrete
- Floors to be finished floor.
- All doors to be 8'0" tall unless noted otherwise
- All exterior doors to be blocked out 1 ½" at slab and installed with recessed 2x6 below threshold.
- 2x6 below threshold to be anchored to slab and sealed to prevent water infiltration.
- 1R1S height = 72" after finish floor, 2R1S height = 84" after finish floor to top of shelf, bottom rod at 42" after finish floor, 3R3S height= 38" to bottom, 76" to middle and 112" to top.
- Garage walls and ceiling to be textured, standard trim
- All load bearing walls over 10'6" high to be 2x6 balloon framing.
- Verify egress requirements w/window manufacturer

ELECTRICAL NOTES:

- Breaker box to be located on interior wall in garage- see plan
- All plugs and smoke detectors per local codes and located on plan.
- Smoke detectors must be a min. 30" from RAG and should be interconnected so that the activation of one will activate all others.
- All smoke detectors should be in an area accessible by 16' extension ladder or a 6' step ladder.
- Plug for irrigation at 60" AFF in garage
- Exterior Garage coach lights to be at 7'-0" AFF
- Block and wire for fan/ lights at all bedrooms and game room
- Prewire for low voltage OH door opener, opener button to be at 5'0" AFF
- Doorbell button to be at 42" AFF himes per plan- 6" down from ceiling
- Bath vanity plugs to be at 41 ½" AFF
- Install GFCI plugs at all vanities and kitchen counter tops
- Kitchen countertop plugs and switches to be 4'-4" AFF to the top of the box
- Security key pads to be located above switches- Foyer, Master Bedroom and Garage Door
- Walk-in closet lights to be 18" from shelf
- HVAC contractor to supply and install all exhaust fans, electrician to provide wiring
- Recessed lighting fixtures to be installed as required by IECC 502.13
- Provide electric conduit in slab for island and floor plugs- per plan
- Soffit plugs to be exterior rated and switched as shown on plan
- All landscape lighting to be powered by timer per plan
- Mechanicals to be located in attic and accessible per plan
- Dimmer Switch locations per homeowner
- Wiring for Smart House System (if selected) (Security, Audio, Lighting, Integration, etc.) to be located per supplier per Homeowner's specifications. If located below stairs or in closet, HVAC contractor to provide fresh air and exhaust for media equipment.
- Provide switch to Pool Lighting (if applicable).
- Verify Electrical/Plumbing requirements with pool contractor.
- All light switches to be "rocker" type, Switches and plugs to be White Decora.

ELEVATION NOTES:

- Masonry material to within 12"of the finished grade or terrace
- All roof stacks and flashing must be painted to match roof color
- All windows to be trimmed with 2x material at siding/stucco locations
- Provide flashing surround at all windows and exterior doors.
- Masonry above all windows and doors to be supported by steel lintels on masonry-each side (including where wood headers are designated).
- All masonry ledges to be 5 ½"
- All masonry projections to be ¾" u.n.o.
- Provide Masonry expansion joints every 20' and within 10' of edge of house
- Vent Attic thru Ridge Vent on Metal Roof (Verify)

SMOKE DETECTORS:

Provide Smoke Alarms- hard wired, interconnected, battery back-up, at each sleeping room and immediate common area outside of sleeping rooms. If applicable, on each additional story including basements and habitable attics. In accordance with 2015 IRC Sec R314

CARBON MONOXIDE ALARMS:

Provide Carbon Monoxide Alarm- hard wired with battery backup, installed outside each separate sleeping area in the immediate vicinity bedrooms in dwelling units within which fuel-fired appliances and/or have an attached garage. In accordance with of the 2015 Sec R315

PROVIDE PERIMETER FENCING DURING CONSTRUCTION

ROOF FRAMING NOTES:

- All lumber to be #2 SYP, 19% M.C. unless noted otherwise.
- All hips, ridges, and valleys to be one mill size larger than the rafters they are supporting, unless noted otherwise.
- Transfer all load bearing points to foundation unless noted otherwise.
- Brace or purlin all rafters to load bearing walls or beams if span is greater than maximum according to the 2015 IRC
- All rafter splices shall be braced
- Purlins to be same depth of rafters they are supporting unless noted otherwise.
- U.N.O All rafters to be 2x8's #2 SYP @ 24" o.c. with 2x10 hip, ridge and valley rafters.
- All exterior openings to be load bearing.
- Provide collar ties at 4'-0" o.c. on all ridges.
- Builder accepts full responsibility for checking layout to assure current conformity to local building codes. Should any changes be made to this layout by the builder or his representatives, builder accepts full liability for amended layout.
- Framing contractor to compare all framing plans from structural engineer or truss manufacturer to this layout. Any discrepancy should be reported to the builder immediately.
- Sub-contractor shall not cut or otherwise alter any pre-fabricated or engineered framing

TEXAS CUSTOM HOME DESIGN, LLC

Austin, Texas 78734

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www.texascustomhomedesign.com

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Project Name:  
SINGLE FAMILY RESIDENCE  
133 E WOODLAWN AVE  
SAN ANTONIO, TX 78212  
Job Number:  
0623  
Edition:  
PERMIT DRAWING

DRAFT PLAN SET 8.1.23

REVISED FLOOR PLAN

PERMIT SET

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Sheet Information



PERMIT 8.1.23 EB  
Issued: 5.12.21  
Drawn By: EB Checked By:  
COVER

G00



PROJECT INFORMATION

REMODEL & ADDITION

xxx

GRID Zoning: Zoning

ZZZ -

ARCHITECTURAL

SHEET NUMBER	SHEET NAME
G00	COVER
A100	FLOORPLAN-EXISTING
A102	FLOORPLAN-PROPOSED
A103	FLOORPLAN-PROPOSED
A200	ELEVATIONS
A201	ELEVATIONS
A600	ROOF PLAN

Project Name:

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Sheet Information

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CERTIFICATION

Eleni Befekadu

CERTIFICATION NO: 44-797

TM


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Drawn By: EB Checked By:

SITE PLAN




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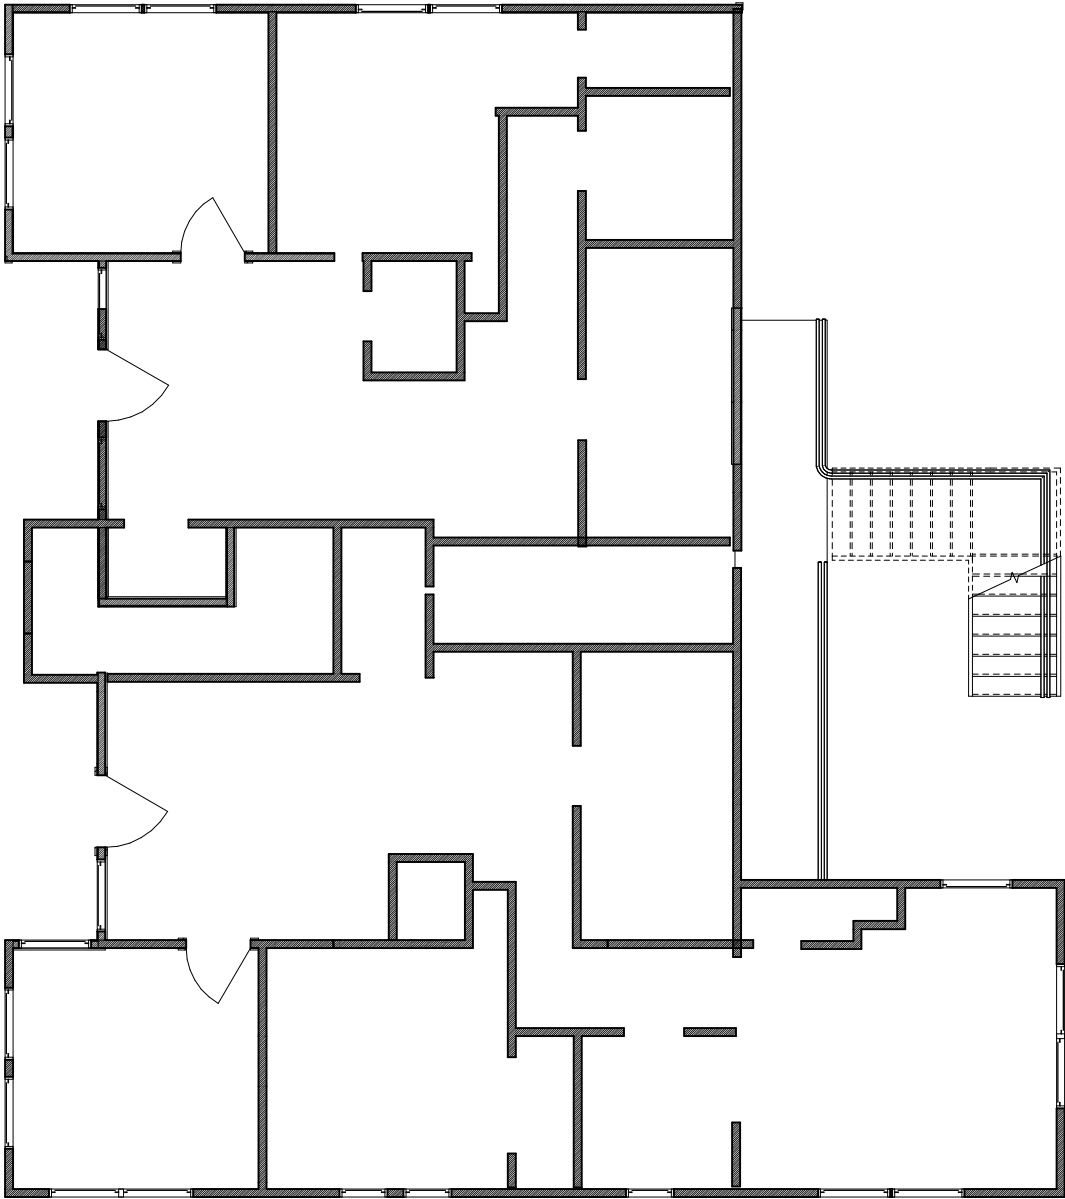


LEGAL DESCRIPTION  
LOT 22 AND THE WEST 12 FEET OF LOT 23, BLOCK 16, NEW CITY BLOCK 1705, ADAMS LAUREL HEIGHTS, IN THE CITY OF SAN ANTONIO, BEXAR COUNTY, TEXAS, ACCORDING TO THE MAP OR PLAT THEREOF RECORDED IN VOLUME 65, PAGE 4, DEED AND PLAT RECORDS OF BEXAR COUNTY, TEXAS.

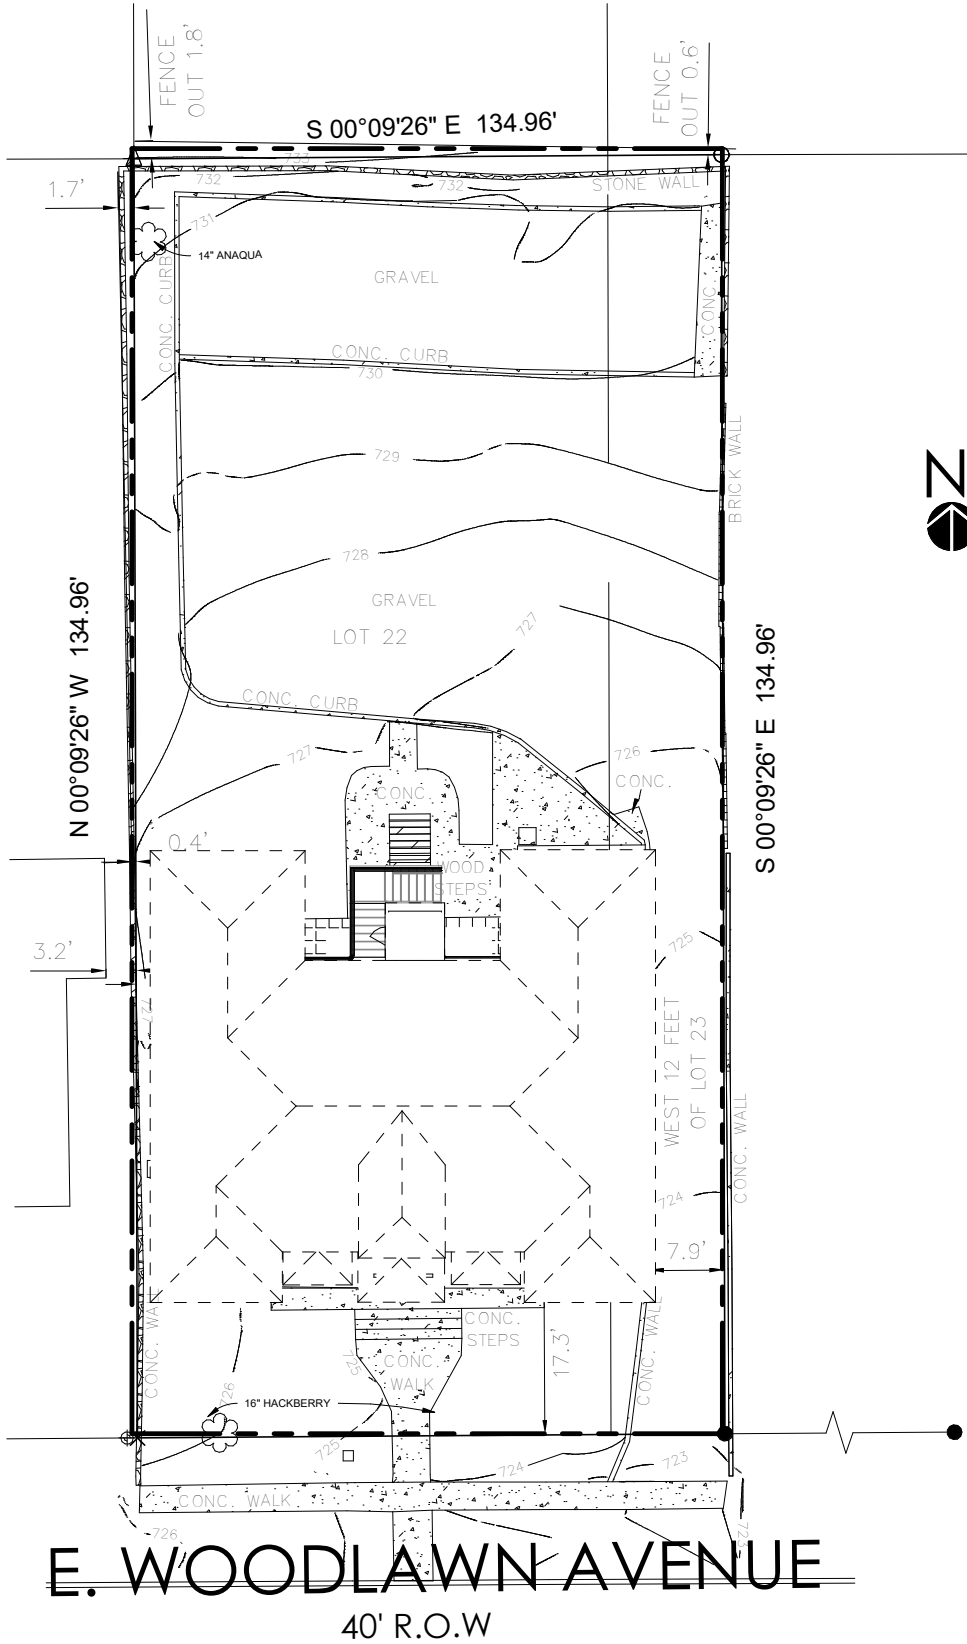1 01 - Plan - Site - 1"=20'  
1"=10'-0" (22x34) 1"=20'-0" (11x117)

DRAWING LEGEND - PHASE

	NEW
	DEMO
	EXISTING



1 FIRST FLOOR PLAN-EXISTING  
1/4" = 1'-0" (22x34) 1/8" = 1'-0" (11x17)

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Project Name:  
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**133 E WOODLAWN AVE**  
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
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DRAFT PLAN SET 8.1.23  
REVISED FLOOR PLAN  
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FLOORPLAN-EXISTING


A100

DRAWING LEGEND - PHASE

NEW

DEMO

EXISTING

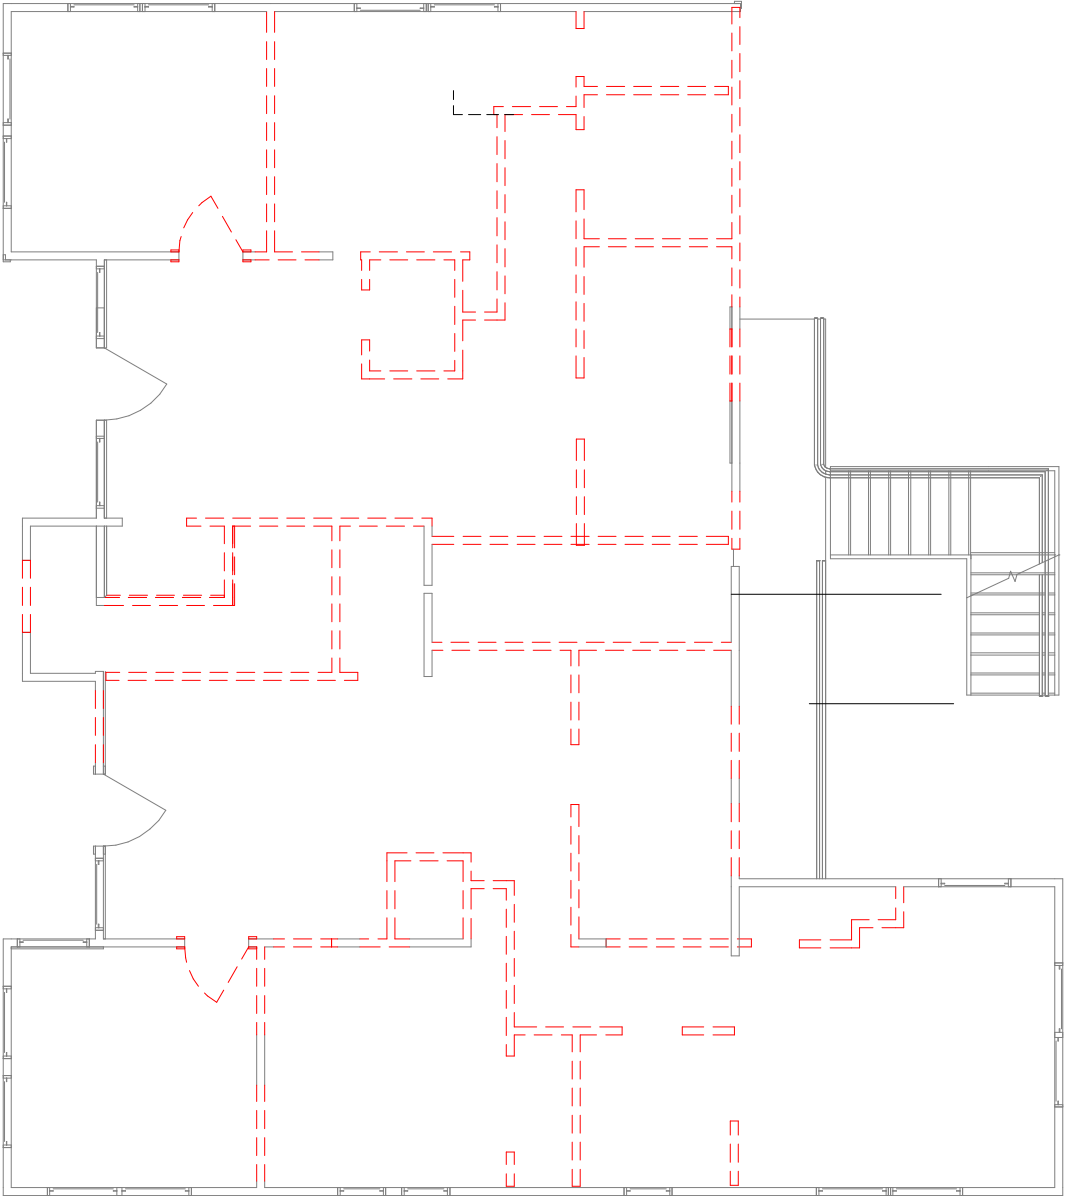

1 FIRST FLOOR PLAN-DEMO  
1/4" = 1'-0" (22x34) 1/8" = 1'-0" (11x17)

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
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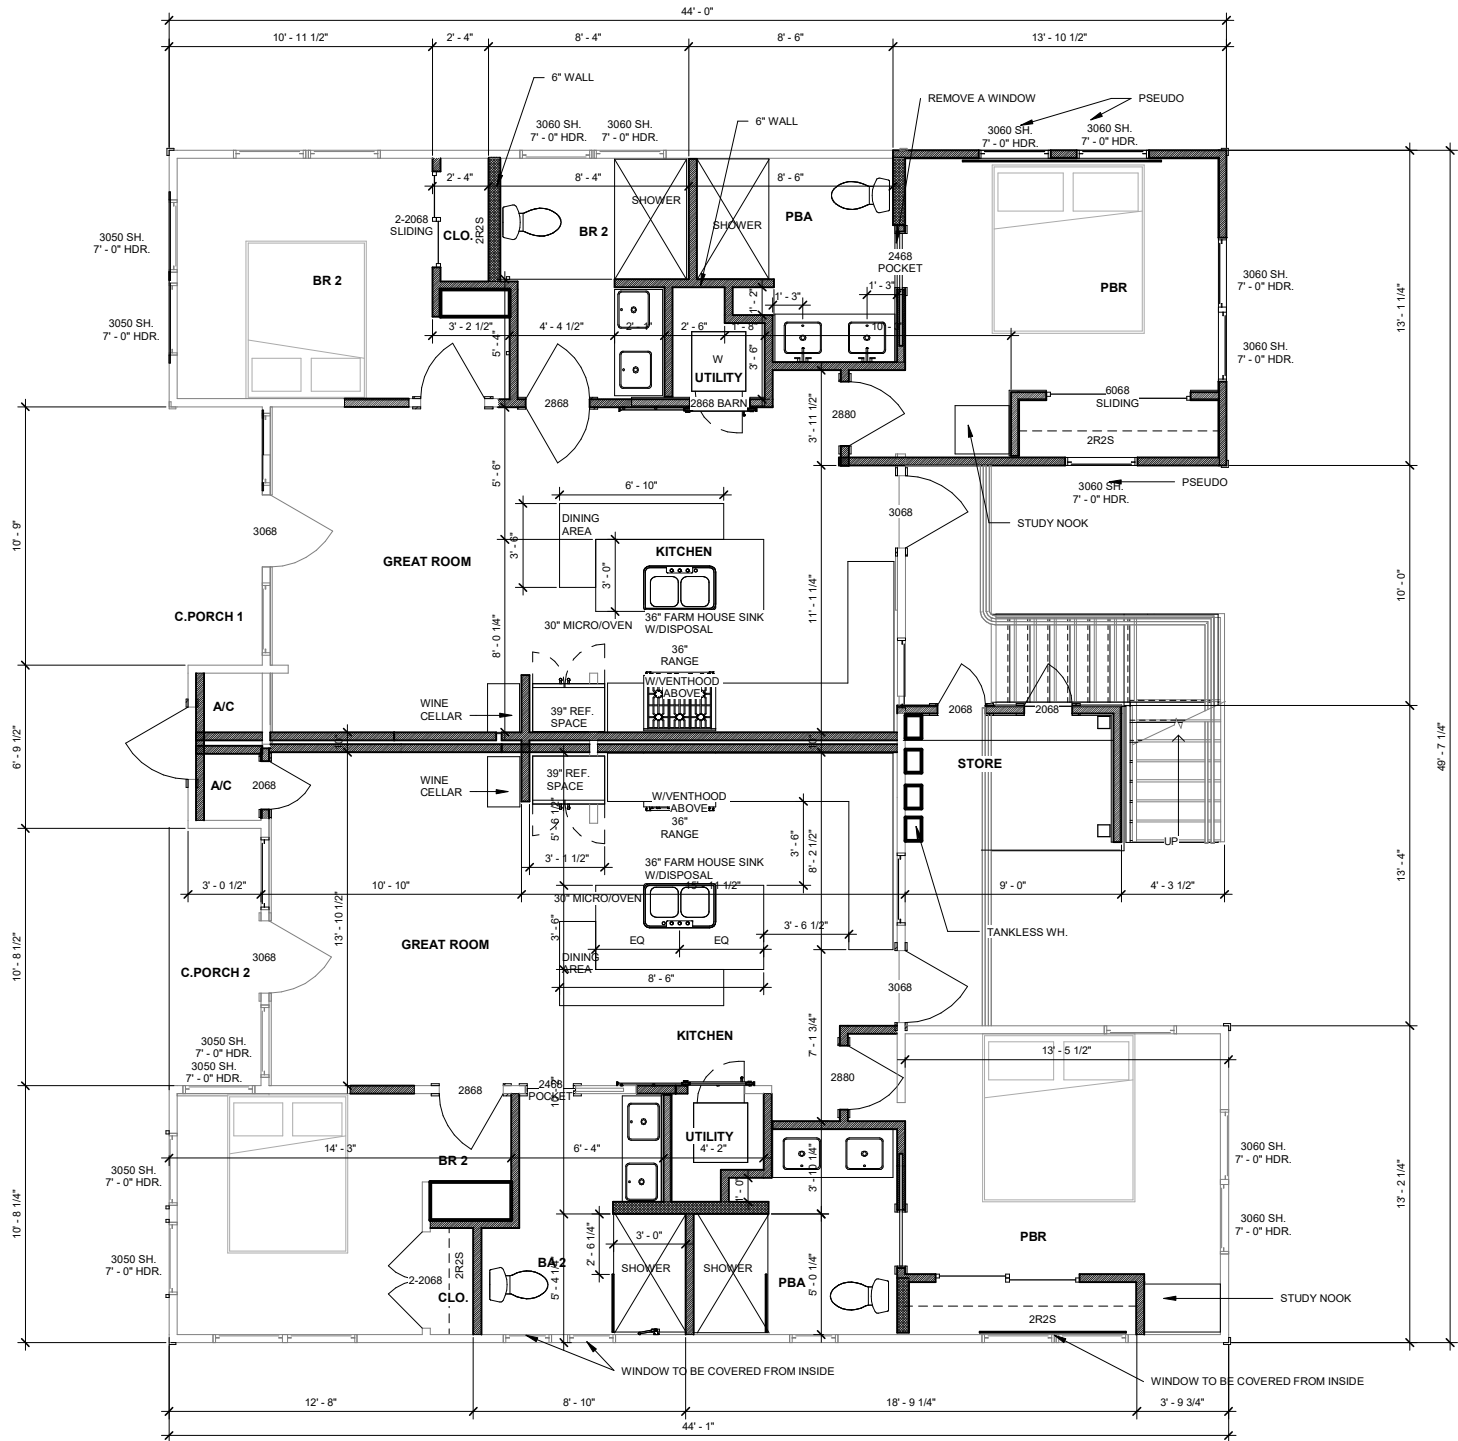


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FLOORPLAN-DEMO

A101



FIRST FLOOR PLAN

1/4" = 1'-0" (22x34) 1/8" = 1'-0" (11x17)

DRAWING LEGEND

- 4" WALL
- 6" WALL
- CARPET
- WOOD
- TILE
- CONCRETE

DRAWING LEGEND - PHASE

- NEW
- DEMO
- EXISTING

WINDOW LEGEND

- CSMT - CASEMENT WINDOW
- HS - HORIZONTAL SLIDING
- FG - FIXED GLASS
- TEMP. - TEMPERED GLASS
- HDR - HEADER (TOP OF WINDOW)
- 3050 - 3'-0" x 5'-0"
- EGRESS - WINDOW DESIGNATED FOR EGRESS FROM A SPACE
- SDL - SIMULATED DIVIDED LITE

DOOR LEGEND

- 1/2 GL - HALF GLASS
- SL GL - SLIDING GLASS
- X - FIXED DOOR
- O - OPERATIONAL DOOR
- C.O. - CASSED OPENING
- FG - FULL GLASS
- SLFD - SLIDE FOLD
- OHGD - OVERHEAD GARAGE DOOR
- DOOR ASSEMBLY - COMBINATION OF DOORS/WINDOWS - SEE DETAIL
- 3068 ARCH - ARCHED DOOR 3'-0" WIDE & 6'-8" TO TOP
- LH - LEFT HAND
- RH - RIGHT HAND
- OSH - OFFSET HINGE
- FR - FRENCH DOOR
- DBL - DOUBLE
- DOOR OPERATIONS
- BIPASS
- POCKET
- BARN



DRAWING LEGEND

- 4" WALL
- 6" WALL
- CARPET
- WOOD
- TILE
- CONCRETE

DRAWING LEGEND - PHASE


- NEW
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- POCKET
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1 SECOND FLOOR PLAN

1/4" = 1'-0" (22x34) 1/8" = 1'-0" (11x17)





2 REAR EXTERIOR ELEVATION  
1/4" = 1'-0" (22x34) 1/8" = 1'-0" (11x17)

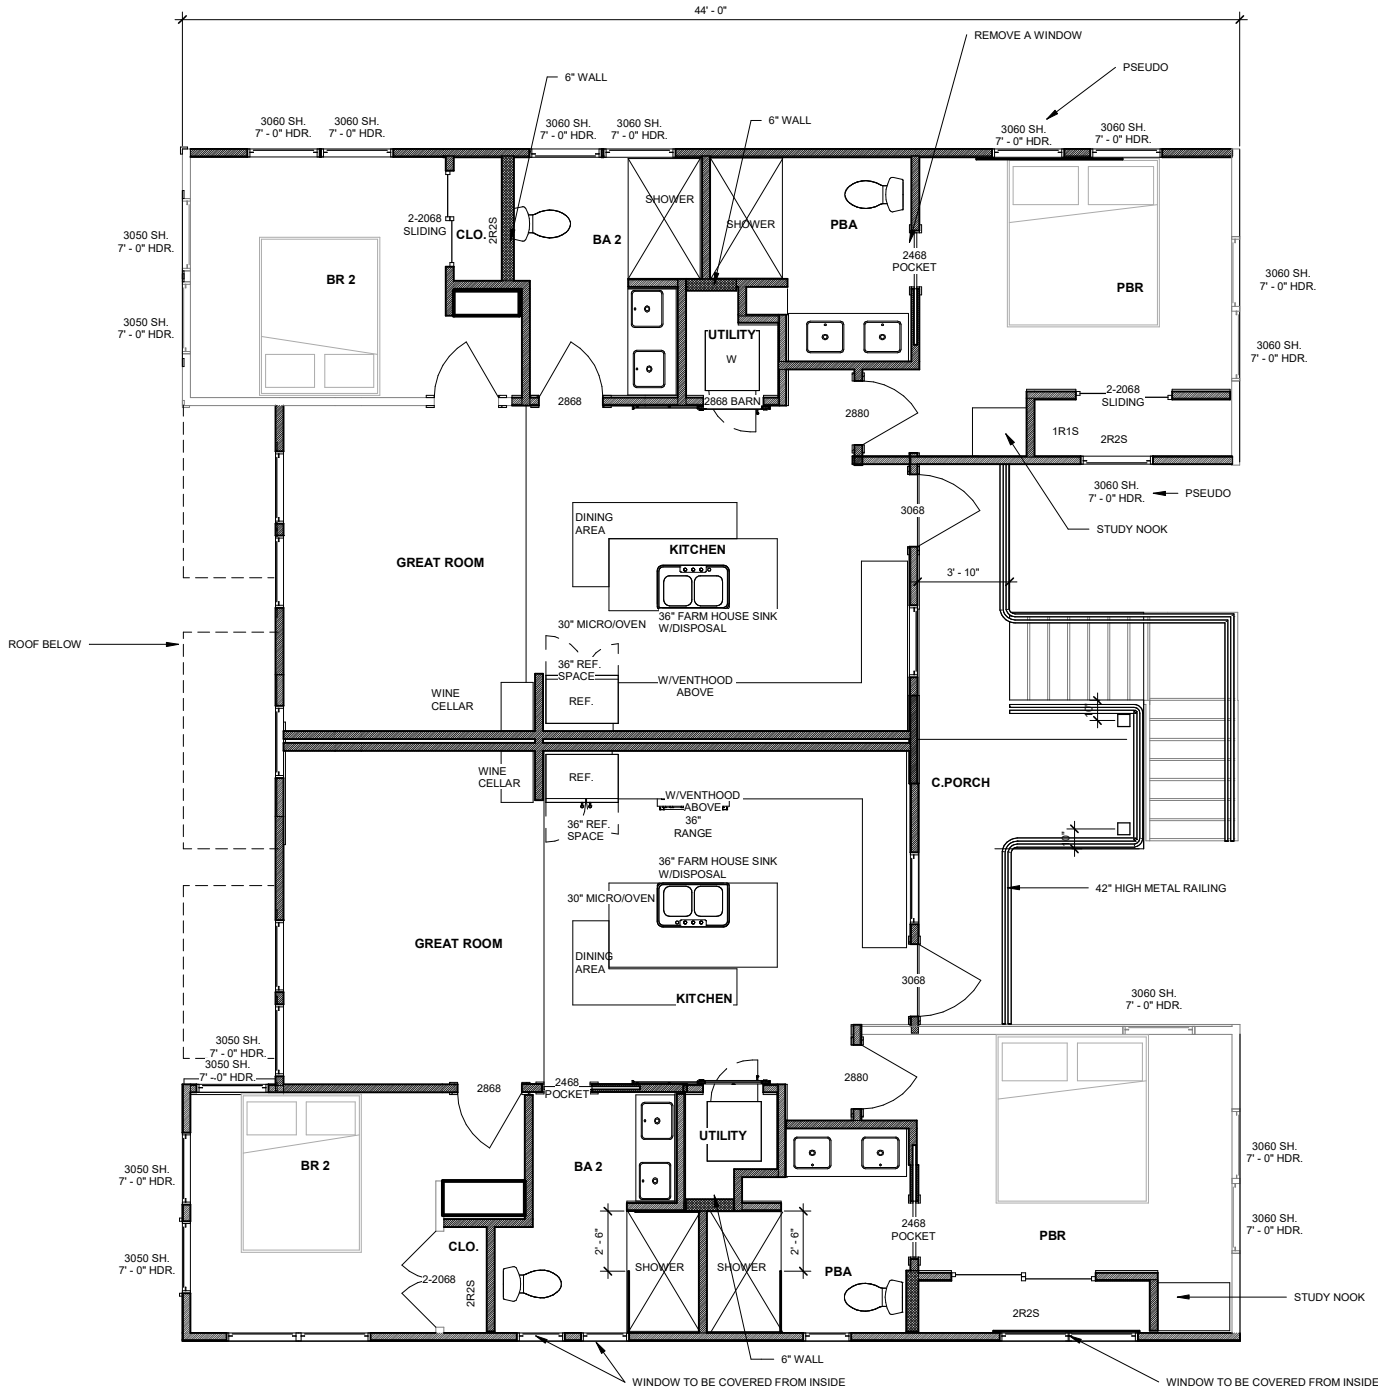


1 FRONT EXTERIOR ELEVATION  
1/4" = 1'-0" (22x34) 1/8" = 1'-0" (11x17)



2 RIGHT EXTERIOR ELEVATION

1/4" = 1'-0" (22x34) 1/8" = 1'-0" (11x17)

NOTE - RAILINGS TO MATCH WITH HISTORICL DETAIL BELOW

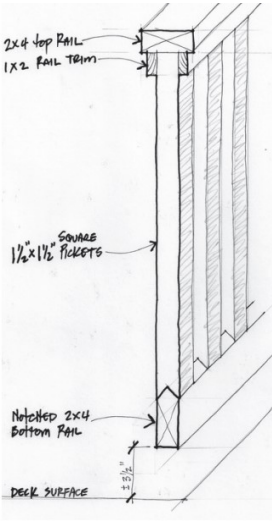

1 REAR EXTERIOR ELEVATION

1/4" = 1'-0" (22x34) 1/8" = 1'-0" (11x17)



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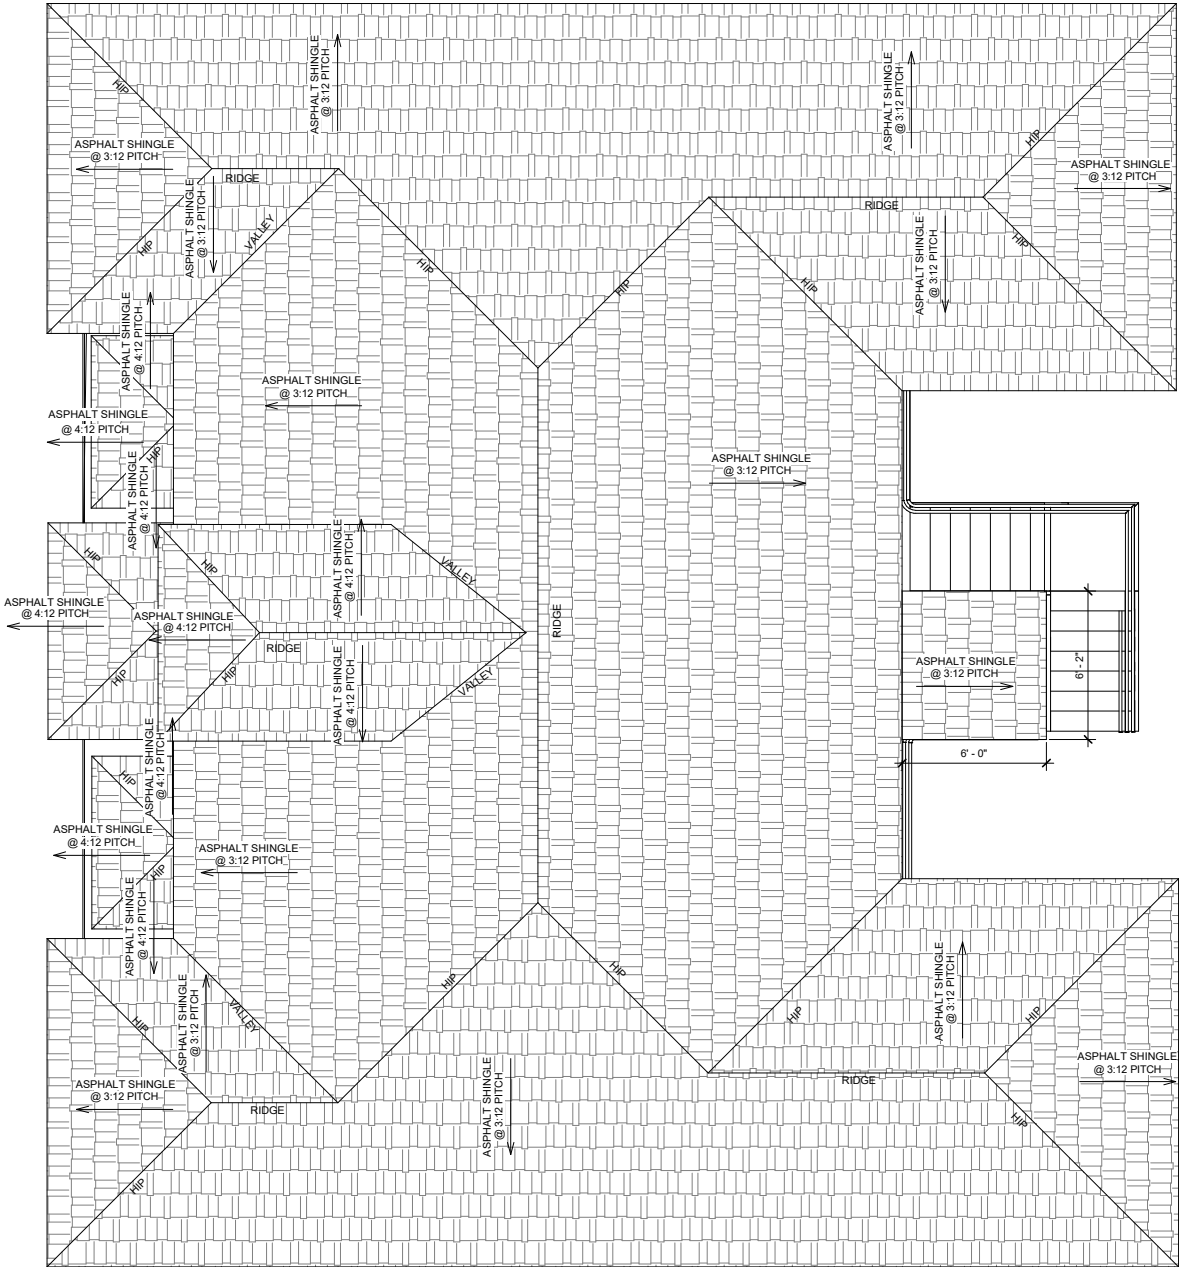
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ROOF PLAN

A600



1 ROOF PLAN

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