AREA CALCULATIONS:

FIRST FLOOR - NEW CONSTRUCTION ADDITION 220 S.F.

TOTAL LIVING AREA NEW CONSTRUCTION 220 S.F.

INCLUDES CONCRETE STONE/BRICK LUG

AIR BARRIER AND INSULATION INSTALLATION ALONG

CONDITIONED PERIMETER/ BUILDING THERMAL ENVELOPE

R402.4.1Building thermal envelope.

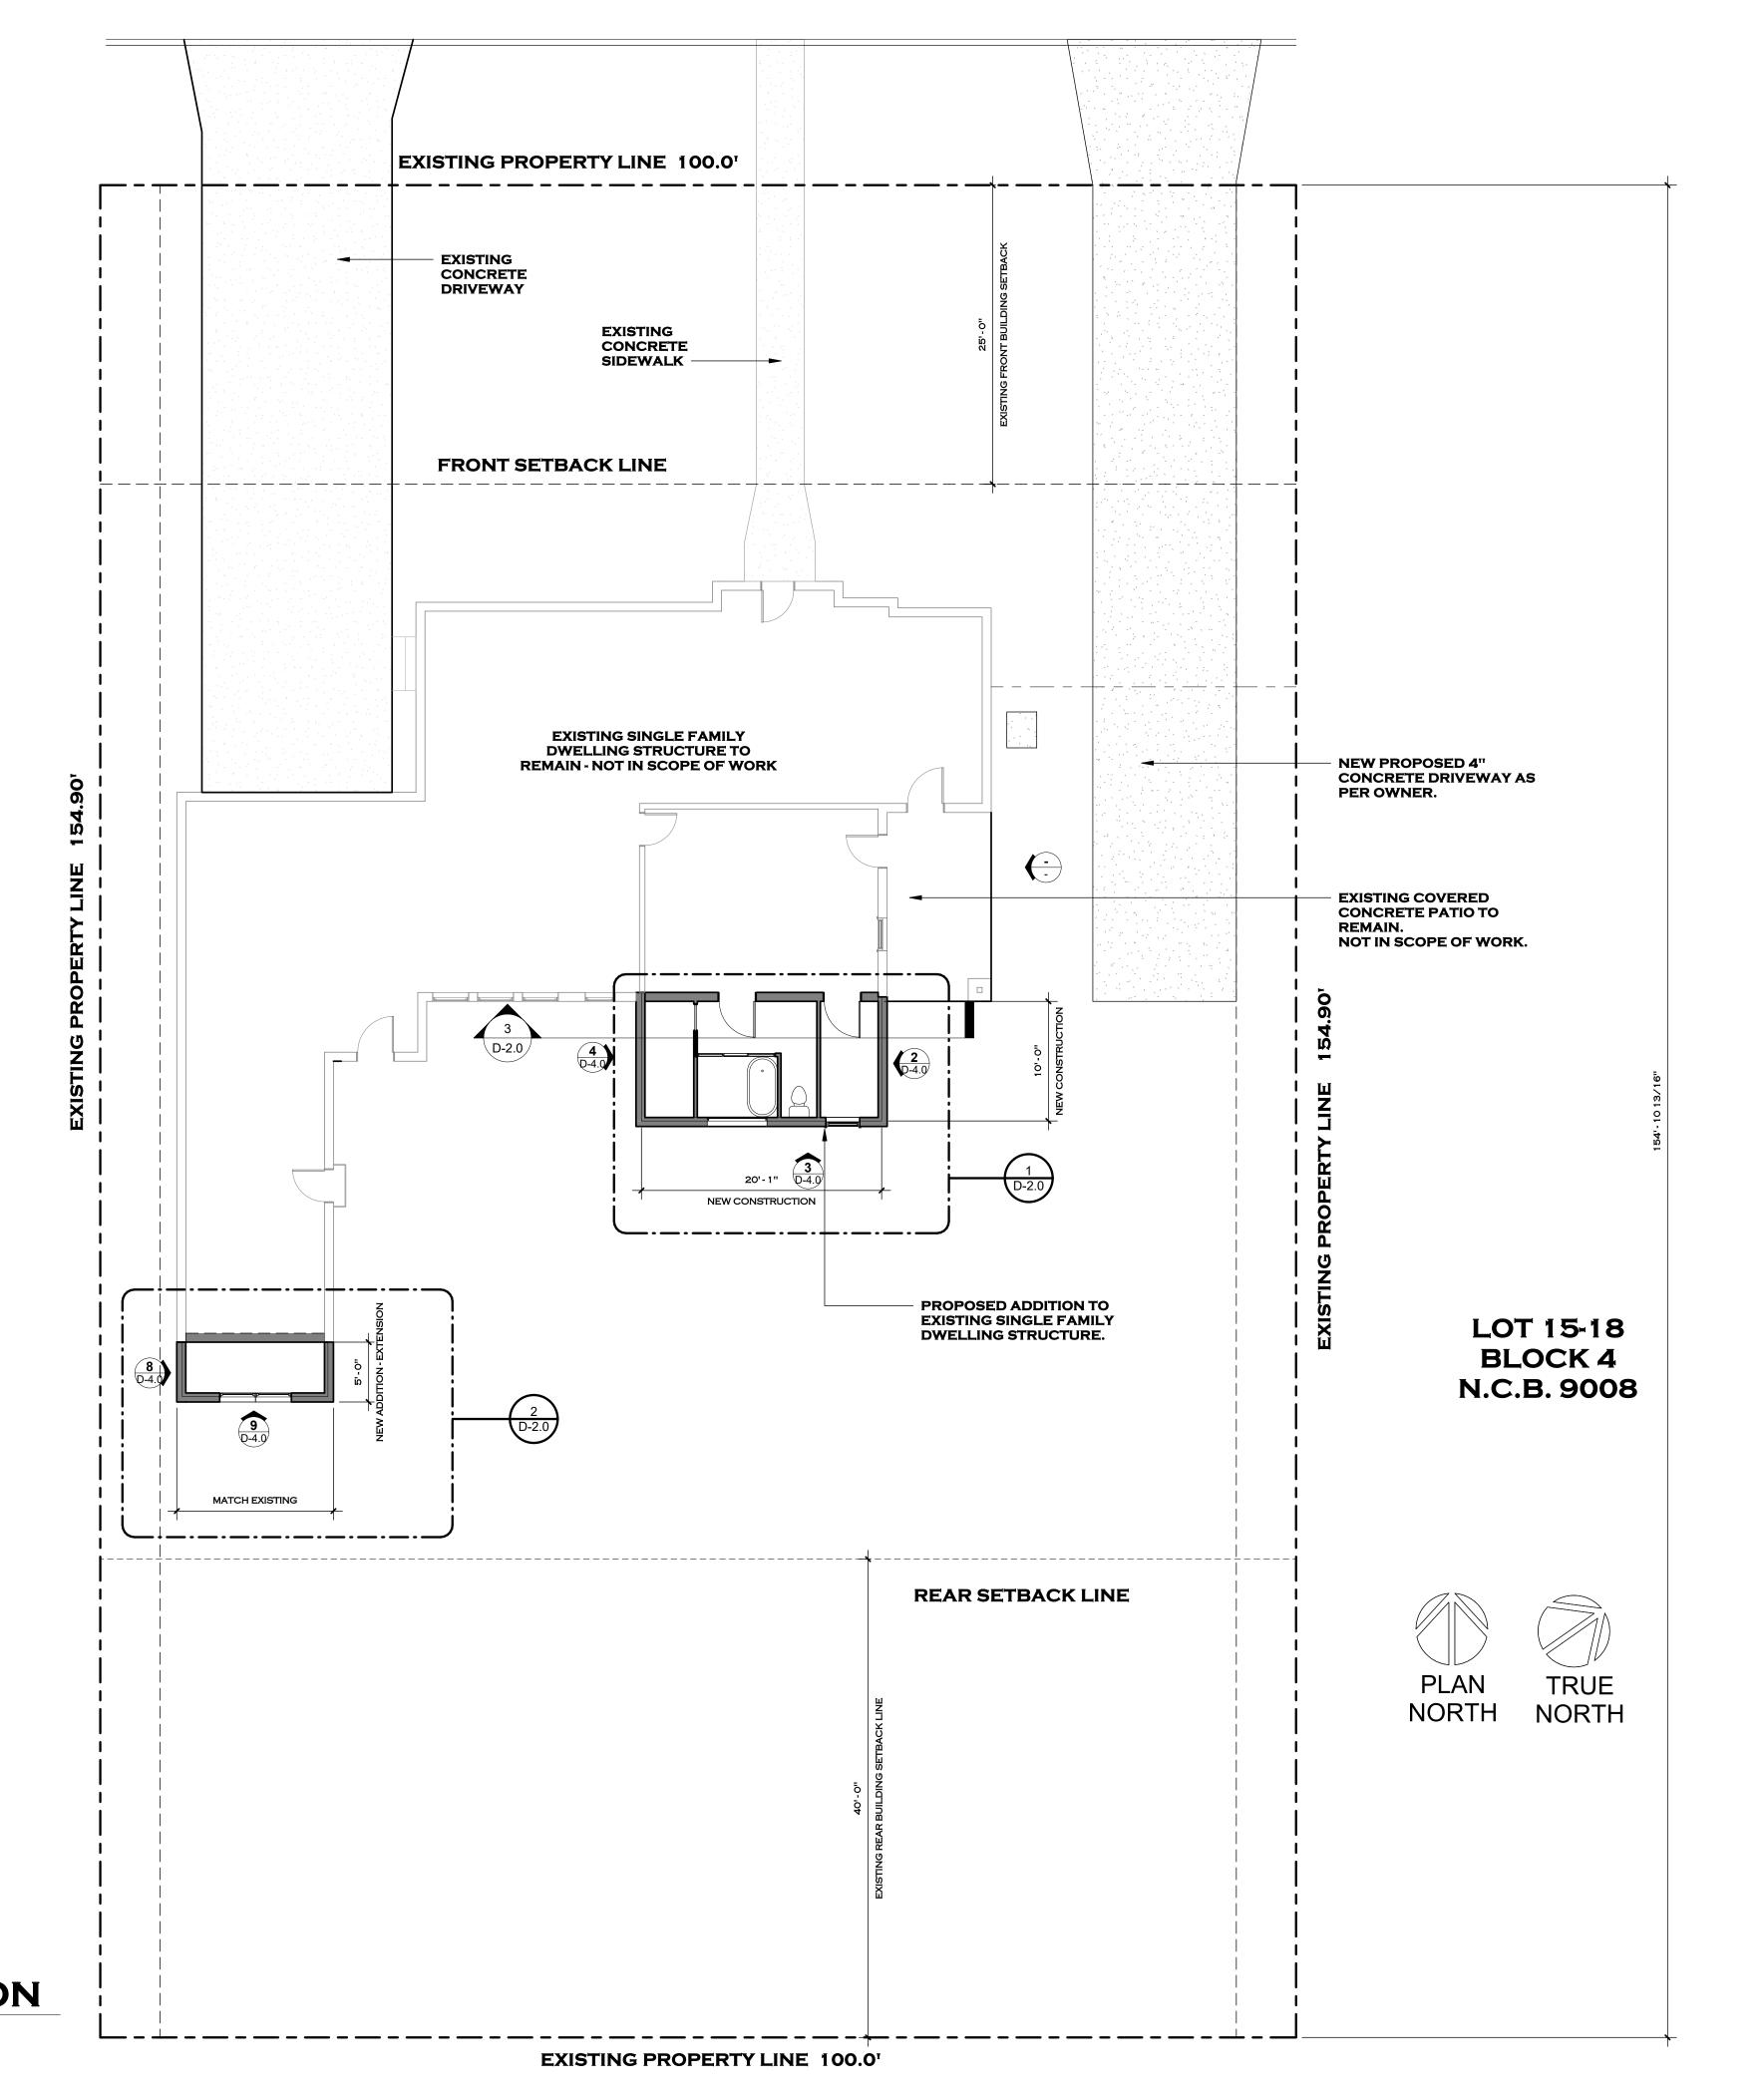
The building thermal envelope shall comply with Sections R402.4.1.1 through R402.4.1.3. The sealing methods between dissimilar materials shall allow for differential expansion and contraction.

R402.4.1.1 Installation.

The components of the building thermal envelope as indicated in Table R402.4.1.1 shall be installed in accordance with the manufacturer's instructions and the criteria indicated in Table R402.4.1.1, as applicable to the method of construction. Where required by the code official, an approved third party shall inspect all

3LE R402.4.1.1 All	R BARRIER, AIR SEALING AND INSULATION INST	ALLATION*	
COMPONENT	AIR BARRIER CRITERIA	INSULATION INSTALLATION CRITERIA	
eneral requirements	A continuous air barrier shall be installed in the building envelope.	Air-permeable insulation shall not be used as a sealing material.	
	Breaks or joints in the air barrier shall be sealed.		
eiling/attic	The air barrier in any dropped ceiling or soffit shall be aligned with the insulation and any gaps in the air barrier shall be sealed.	The insulation in any dropped ceiling/soffit shall be aligned with the air barrier.	
	Access openings, drop down stairs or knee wall doors to unconditioned attic spaces shall be sealed.		
falls	The junction of the foundation and still plate shall be sealed. The junction of the top plate and the top of exterior walls shall be sealed.	Cavities within corners and headers of frame walls shall be insulated by completely filling the cavity with a material having a thermal resistance, R-value, of not less than R 3 per inch. Exterior thermal envelope insulation for framed walls shall be installed in substantial contact and continuous alignment with the air barrier.	
	Knee walls shall be sealed.		
findows, skylights and pors	The space between framing and skylights, and the jambs of windows and doors, shall be sealed.	-	
im joists	Rim joists shall include an exterior air barrier. ^b The junctions of the rim board to the sill plate and the rim board and the subfloor shall be air sealed.	Rim joists shall be insulated so that the insulation maintains permanent contact with the exterior rim board.	
oors, including antilevered floors and oors above garages	The air barrier shall be installed at any exposed edge of insulation.	Floor framing cavity insulation shall be installed to maintain permanent contact with the underside of subfloor decking. Alternatively, floor framing cavity insulation shall be in contact with the top side of sheathing, or continuous insulation installed on the underside of floor framing and extending from the bottom to the top of all perimeter floor framing members.	
	Exposed earth in unvented crawl spaces shall be covered with a Class I vapor retarder/air barrier in accordance with Section R402.2.10.	Crawl space insulation, where provided instead of floor insulation, shall be installed in accordance with Section R402.2.10.	
asement crawl space nd slab foundations	Penetrations through concrete foundation walls and slabs shall be air sealed.	Conditioned basement foundation wall insulation shall be installed in accordance with Section R402.2.8.1.	
	Class 1 vapor retarders shall not be used as an air barrier on below-grade walls and shall be installed in accordance with Section R702.7 of the <i>International Residential Code</i> .	Slab-on-grade floor insulation shall be installed in accordance with Section R402.2.10.	
	Duct and flue shafts to exterior or unconditioned space shall be sealed.	Insulation shall be fitted tightly around utilities passing through shafts and penetrations in the building thermal envelope to maintain required R -value.	
hafts, penetrations	Utility penetrations of the air barrier shall be caulked, gasketed or otherwise sealed and shall allow for expansion, contraction of materials and mechanical vibration.		
arrow cavities	Narrow cavities of 1 inch or less that are not able to be insulated shall be air sealed.	Batts to be installed in narrow cavities shall be cut to fit or narrow cavities shall be filled with insulation that on installation readily conforms to the available cavity space.	
arage separation	Air sealing shall be provided between the garage and conditioned spaces.	Insulated portions of the garage separation assembly shall be installed in accordance with Sections R303 and R402.2.7.	
ecessed lighting	Recessed light fixtures installed in the building thermal envelope shall be air sealed in accordance with Section R402.4.5.	Recessed light fixtures installed in the building thermal envelope shall be airtight and IC rated, and shall be buried or surrounded with insulation.	
lumbing, wiring or other ostructions	All holes created by wiring, plumbing or other obstructions in the air barrier assembly shall be air sealed.	Insulation shall be installed to fill the available space and surround wiring, plumbing, or other obstructions, unless the required R-value can be met by installing insulation and air barrier systems completely to the exterior side of the obstructions.	
hower/tub on exterior all	The air barrier installed at exterior walls adjacent to showers and tubs shall separate the wall from the shower or tub.	Exterior walls adjacent to showers and tubs shall be insulated.	
ectrical/phone box on sterior walls	The air barrier shall be installed behind electrical and communication boxes. Alternatively, air-sealed boxes shall be installed.	-	
VAC register boots	HVAC supply and return register boots that penetrate building thermal envelope shall be sealed to the subfloor, wall covering or ceiling penetrated by the boot.	=	
oncealed sprinklers	Where required to be sealed, concealed fire sprinklers shall only be sealed in a manner that is recommended by the manufacturer. Caulking or other adhesive sealants shall not be used to fill voids between fire sprinkler cover plates and walls or ceilings.	_	

e. Inspection of log walls shall be in accordance with the provisions of ICC 400.
 b. Air barrier and insulation full enclosure is not required in unconditioned/ventileted attic spaces and at rim joists



OVERALL EXISTING SITE PLAN W/ PROPOSED ADDITION

DESIGNER:

TEL: (210) 452-4895

PROJECT DESCRIPTION:

PROJECT:

REVISIONS:

PROJECT STATUS

SHEET TITLE

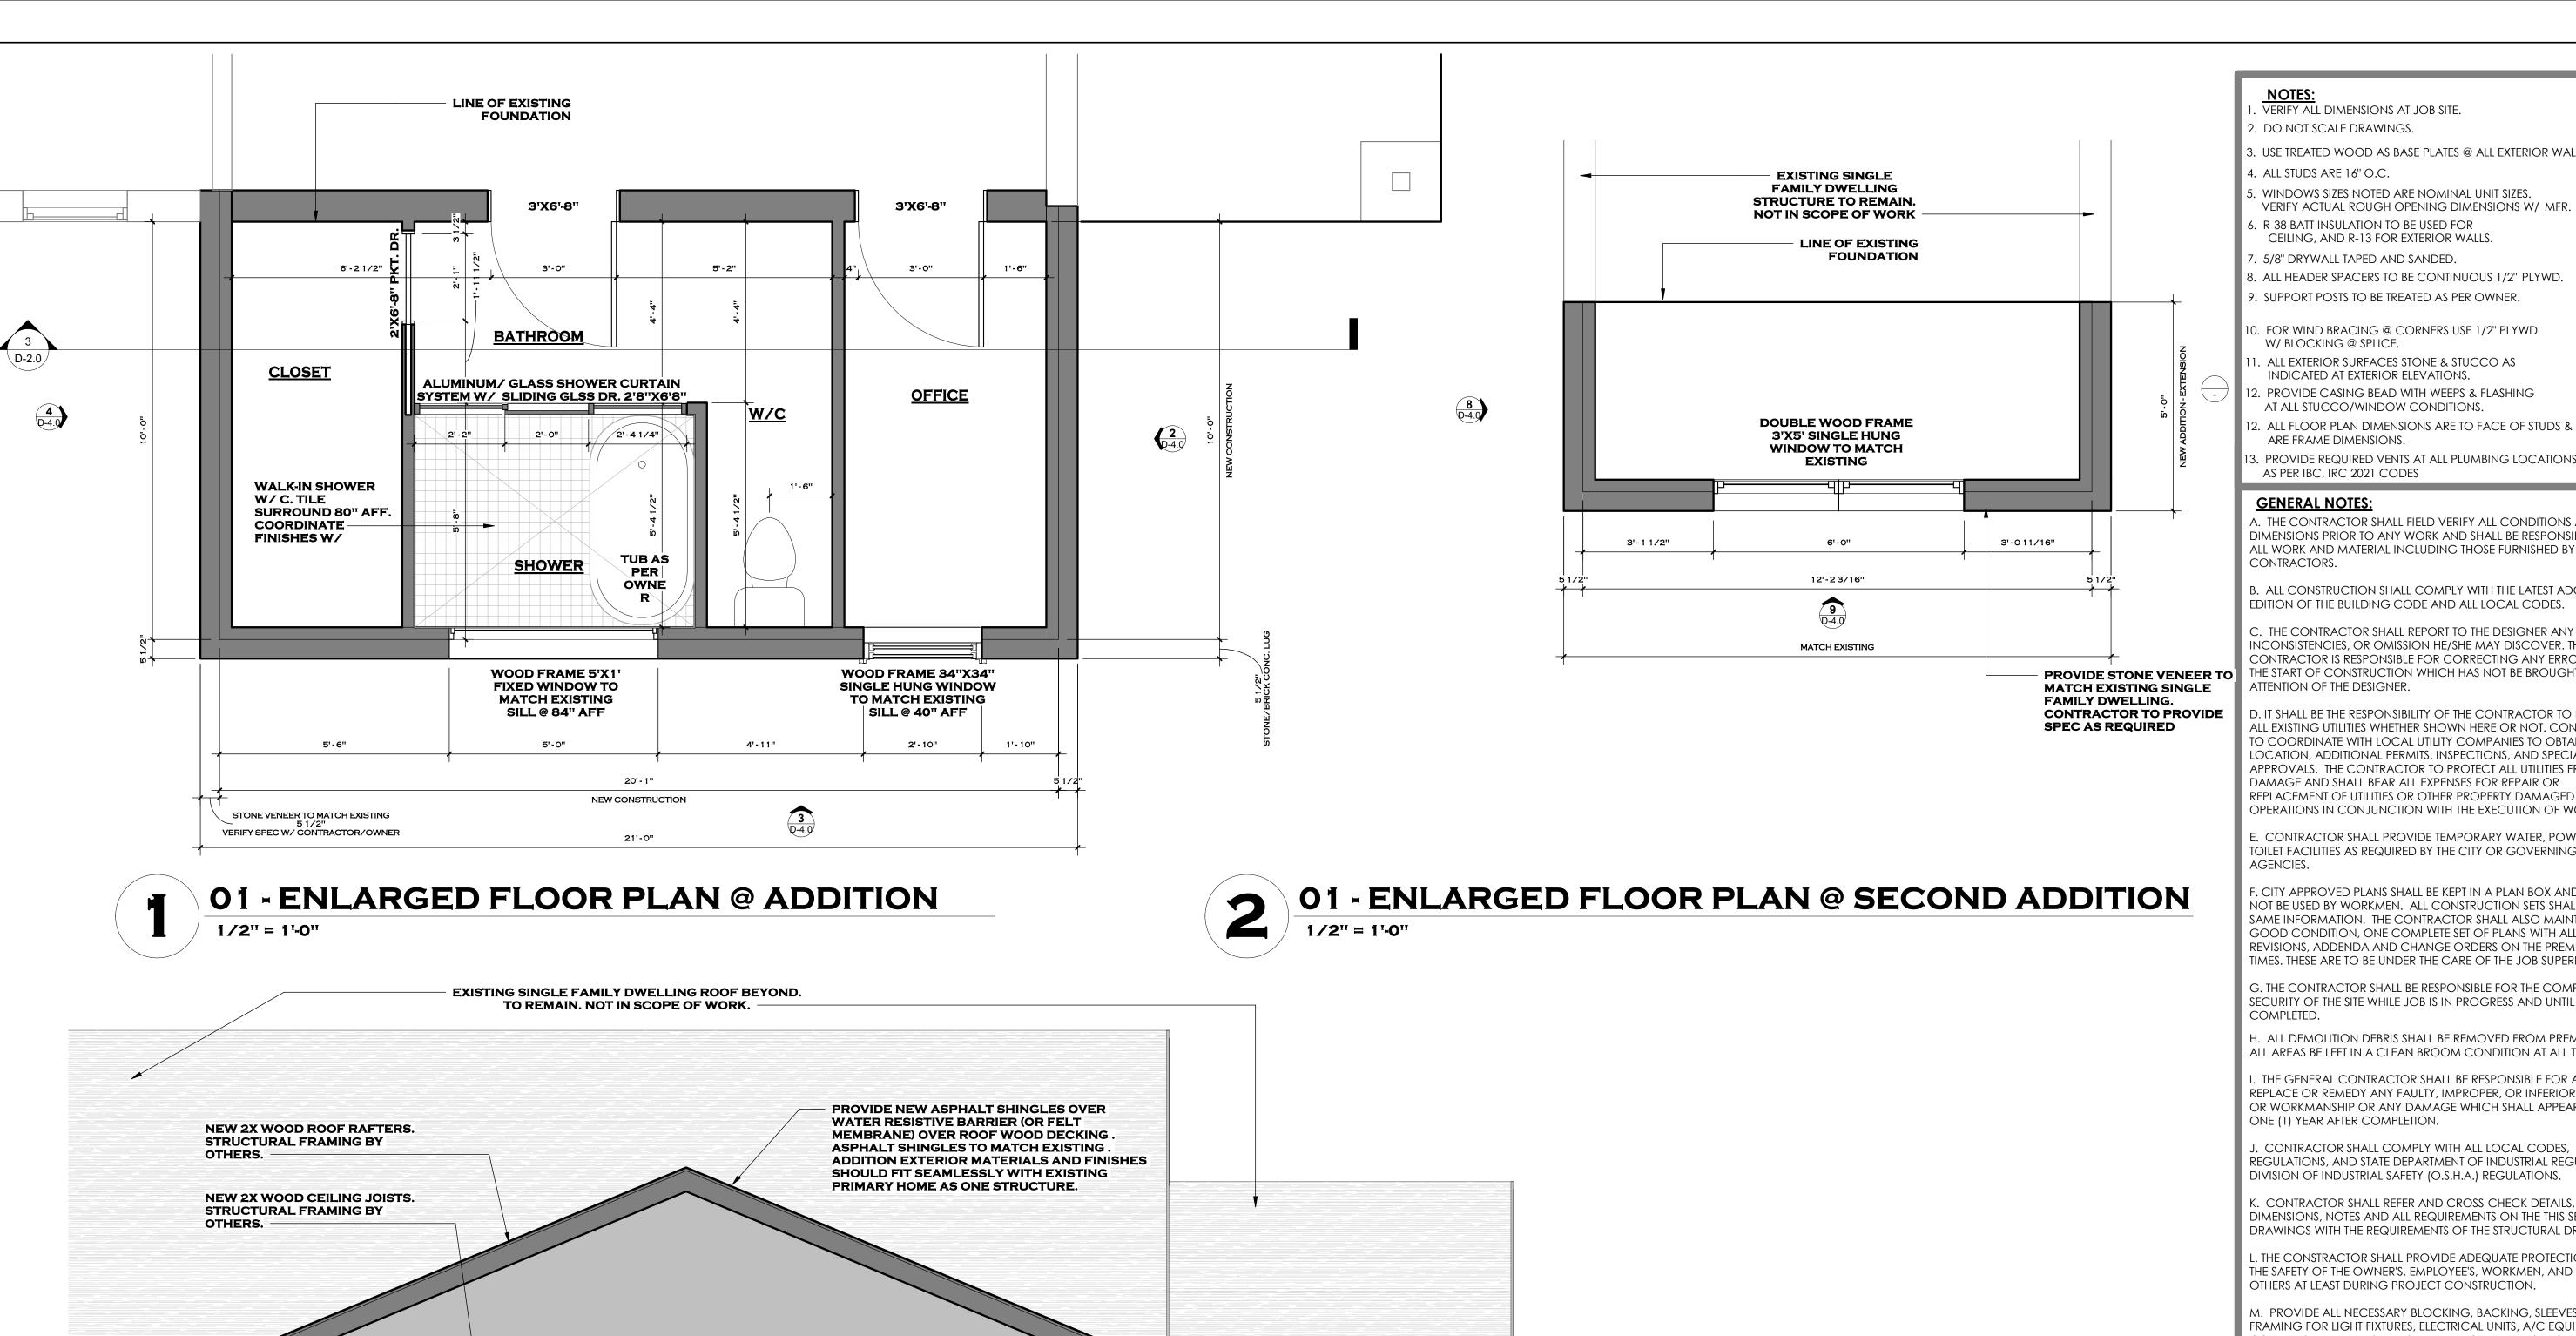
OVERALL EXISTING & NEW CONSTRUCTION SITE PLAN

PROJECT NO.

DRAWN BY.

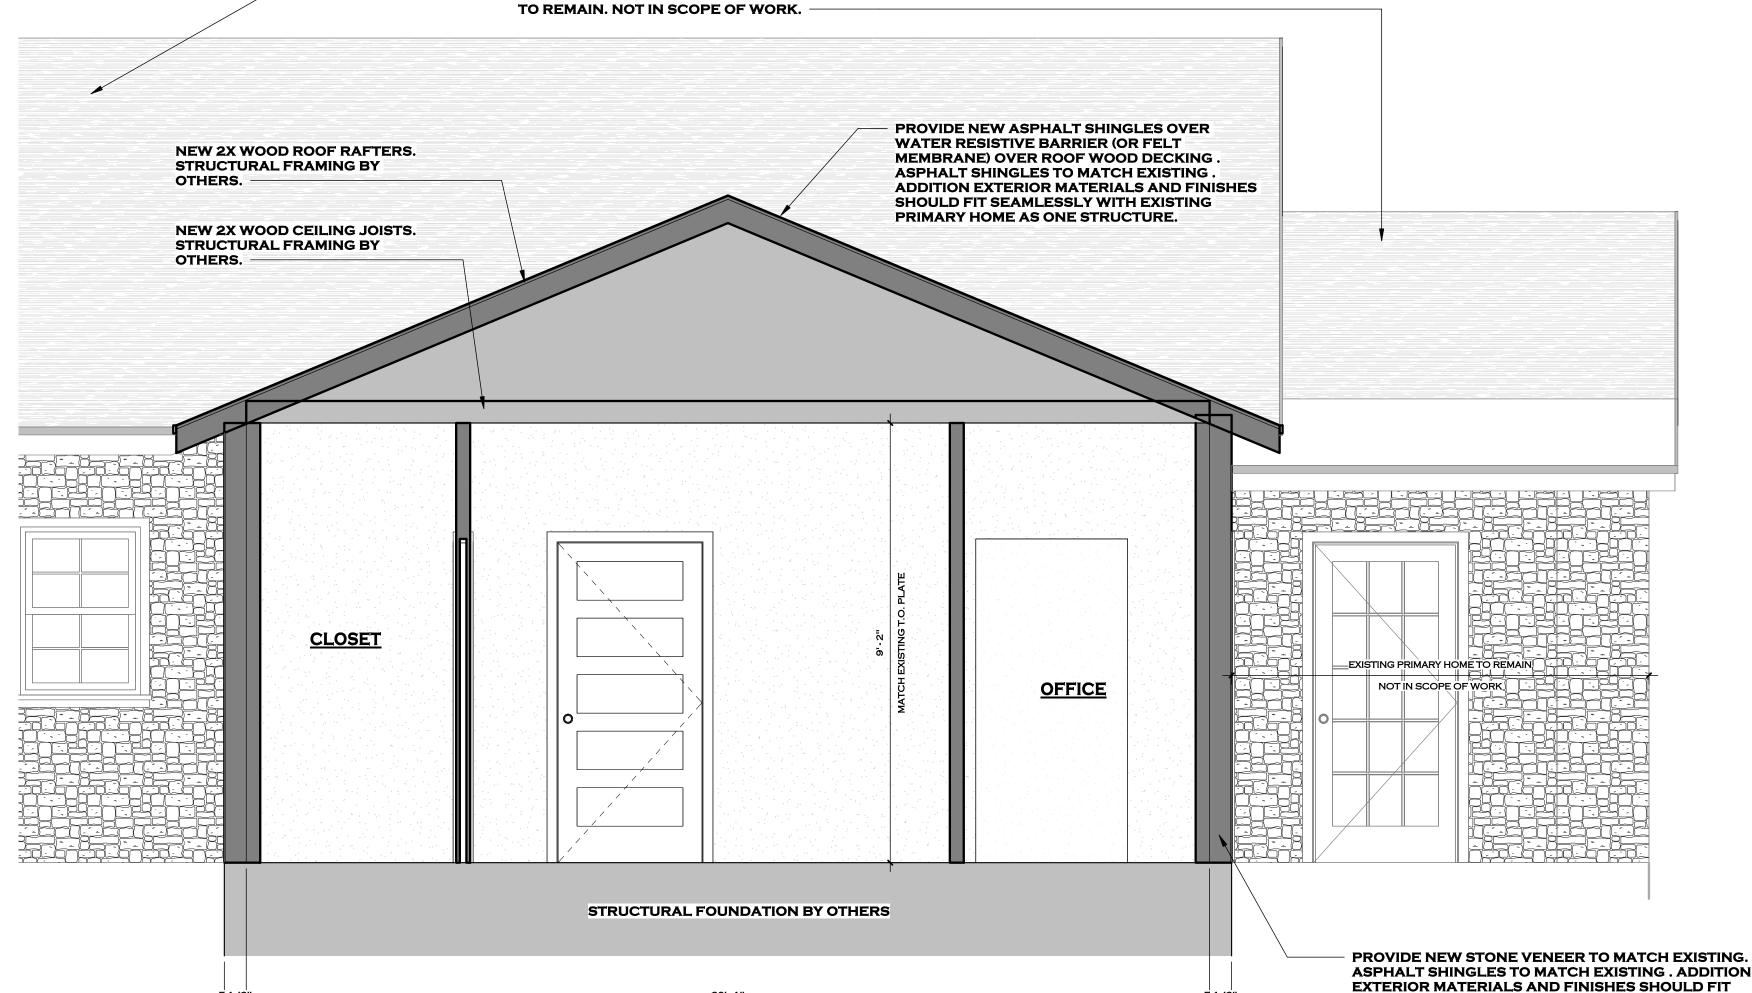
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SEAMLESSLY WITH EXISTING PRIMARY HOME AS ONE

STRUCTURE.



BUILDING SECTION @ ADDITION

1/2" = 1'-0"

- VERIFY ALL DIMENSIONS AT JOB SITE.
- 2. DO NOT SCALE DRAWINGS.
- 3. USE TREATED WOOD AS BASE PLATES @ ALL EXTERIOR WALLS
- 4. ALL STUDS ARE 16" O.C.
- VERIFY ACTUAL ROUGH OPENING DIMENSIONS W/ MFR.
- . R-38 BATT INSULATION TO BE USED FOR CEILING, AND R-13 FOR EXTERIOR WALLS.
- 7. 5/8" DRYWALL TAPED AND SANDED.
- 8. ALL HEADER SPACERS TO BE CONTINUOUS 1/2" PLYWD.
- W/ BLOCKING @ SPLICE. . ALL EXTERIOR SURFACES STONE & STUCCO AS
- INDICATED AT EXTERIOR ELEVATIONS.
- 12. PROVIDE CASING BEAD WITH WEEPS & FLASHING AT ALL STUCCO/WINDOW CONDITIONS.
- ARE FRAME DIMENSIONS.
- 3. PROVIDE REQUIRED VENTS AT ALL PLUMBING LOCATIONS AS PER IBC, IRC 2021 CODES

GENERAL NOTES:

A. THE CONTRACTOR SHALL FIELD VERIFY ALL CONDITIONS AND DIMENSIONS PRIOR TO ANY WORK AND SHALL BE RESPONSIBLE FOR ALL WORK AND MATERIAL INCLUDING THOSE FURNISHED BY SUB-CONTRACTORS.

B. ALL CONSTRUCTION SHALL COMPLY WITH THE LATEST ADOPTED EDITION OF THE BUILDING CODE AND ALL LOCAL CODES.

C. THE CONTRACTOR SHALL REPORT TO THE DESIGNER ANY ERROR INCONSISTENCIES, OR OMISSION HE/SHE MAY DISCOVER. THE CONTRACTOR IS RESPONSIBLE FOR CORRECTING ANY ERROR AFTER PROVIDE STONE VENEER TO THE START OF CONSTRUCTION WHICH HAS NOT BE BROUGHT TO THE

> D. IT SHALL BE THE RESPONSIBILITY OF THE CONTRACTOR TO LOCATE ALL EXISTING UTILITIES WHETHER SHOWN HERE OR NOT. CONTRACTOR TO COORDINATE WITH LOCAL UTILITY COMPANIES TO OBTAIN LOCATION, ADDITIONAL PERMITS, INSPECTIONS, AND SPECIAL APPROVALS. THE CONTRACTOR TO PROTECT ALL UTILITIES FROM DAMAGE AND SHALL BEAR ALL EXPENSES FOR REPAIR OR REPLACEMENT OF UTILITIES OR OTHER PROPERTY DAMAGED BY OPERATIONS IN CONJUNCTION WITH THE EXECUTION OF WORK.

E. CONTRACTOR SHALL PROVIDE TEMPORARY WATER, POWER AND TOILET FACILITIES AS REQUIRED BY THE CITY OR GOVERNING

f. CITY APPROVED PLANS SHALL BE KEPT IN A PLAN BOX AND SHALL NOT BE USED BY WORKMEN. ALL CONSTRUCTION SETS SHALL REFLECT SAME INFORMATION. THE CONTRACTOR SHALL ALSO MAINTAIN, IN GOOD CONDITION, ONE COMPLETE SET OF PLANS WITH ALL REVISIONS, ADDENDA AND CHANGE ORDERS ON THE PREMISES AT ALL TIMES. THESE ARE TO BE UNDER THE CARE OF THE JOB SUPERINTENDENT

G. THE CONTRACTOR SHALL BE RESPONSIBLE FOR THE COMPLETE SECURITY OF THE SITE WHILE JOB IS IN PROGRESS AND UNTIL JOB IS

H. ALL DEMOLITION DEBRIS SHALL BE REMOVED FROM PREMISES AND ALL AREAS BE LEFT IN A CLEAN BROOM CONDITION AT ALL TIMES.

I. THE GENERAL CONTRACTOR SHALL BE RESPONSIBLE FOR AND SHALL REPLACE OR REMEDY ANY FAULTY, IMPROPER, OR INFERIOR MATERIAL OR WORKMANSHIP OR ANY DAMAGE WHICH SHALL APPEAR WITHIN ONE (1) YEAR AFTER COMPLETION.

J. CONTRACTOR SHALL COMPLY WITH ALL LOCAL CODES, REGULATIONS, AND STATE DEPARTMENT OF INDUSTRIAL REGULATIONS, DIVISION OF INDUSTRIAL SAFETY (O.S.H.A.) REGULATIONS.

K. CONTRACTOR SHALL REFER AND CROSS-CHECK DETAILS, DIMENSIONS, NOTES AND ALL REQUIREMENTS ON THE THIS SET OF DRAWINGS WITH THE REQUIREMENTS OF THE STRUCTURAL DRAWINGS.

L. THE CONSTRACTOR SHALL PROVIDE ADEQUATE PROTECTION FOR THE SAFETY OF THE OWNER'S, EMPLOYEE'S, WORKMEN, AND ALL OTHERS AT LEAST DURING PROJECT CONSTRUCTION.

M. PROVIDE ALL NECESSARY BLOCKING, BACKING, SLEEVES, FRAMING FOR LIGHT FIXTURES, ELECTRICAL UNITS, A/C EQUIPMENT, COUNTERS, HANDRAILS, RAILS, AND ALL OTHER ITEMS REQUIRING

N. HOME LOCATION & DRIVEWAY CONFIGURATION MAY VARY, VERIFY LOCATION W/ OWNER & BUILDER @ SITE.

O. ATTIC A/C UNIT PROVIDE REQ. ELEC. AND OR GAS W/ OVERFLOW PAN TO OUTSIDE ON PLYWD. DECKING. INSTALL AS PER LOCAL LOCAL.

P. BULLNOSE SHEETROCK @ ALL ARCHES AND TRAFFIC AREAS.

Q. COAX CABLE @ ALL TV & PHONE LOCATIONS.

AREA CALCULATIONS:

FIRST FLOOR - NEW CONSTRUCTION ADDITION 220 S.F.

TOTAL LIVING AREA NEW CONSTRUCTION 220 S.F.

INCLUDES CONCRETE STONE/BRICK LUG

R. ALL FRAMING AND STRUCTURAL DESIGN NEEDS TO MEET 115 M.P.H. WIND CRITERIA AS PER SEC. R301.2 (4).

S. PRESSURE TREATED WOOD OR OTHER APPROVED DECAY-RESISTANT WOOD SILLS, SILL AND SLEEPERS, OR BOTTOM PLATES THAT REST ON CONCRETE OR MASONRY WALLS OR SLABS ON GRADE TO MEET SEC

T. HANDRAILS SHALL BE PROVIDED ON ALL STAIRS/STEPS WITH A MINIMUM OF FOUR (4) RISERS AS PER SEC R311.7.8 (MIN. STAIR TREAD 10", MAX. RISER 7 3/4")

U. OPENINGS BETWEEN THE GARAGE AND THE RESIDENCE SHALL BE EQUIPED W/SOLID WOOD DOORS NOT LESS THAN 1 3/8" THICKNESS, SOLID OR HONEYCOMB CORE STEEL DOORS NOT LESS THAN 1 3/8" THICKNESS, OR 20 MINUTE FIRE-RATED DOORS, EQUIPPED WITH A SELF-CLOSING DEVICE SECTION R302.5.1

HANDRAILS WITH CIRCULAR CROSS SECTION SHALL HAVE AN OUTSIDE DIAMETER OF AT LEAST 1 1/4" AND NOT GREATER THAN 2" AS PER SECTION 311.7.8

W. THE FLOOR PLANS AND DESIGN CONTAINED HEREIN ARE PROPERT) OF THE JT STUDIO AND MAY NOT BE REPRODUCED, ALL OR IN PART WITHOUT WRITTEN CONSENT FROM THE DESIGNER.

X. WE ARE NOT AN ENGINEERING FIRM, WE DO NOT QUALIFY TO BE ONE, NOR ARE WE LICENSED TO DESIGN STRUCTURAL FRAMING, WINDBRACING OR FOUNDATIONS. A LICENSED PROFESSIONAL ENGINEER SHOULD BE CONTRACTED AND CONSULTED REGARDING FRAMING, WINDBRACING AND FOUNDATION DESIGN.

DESIGNER:

TEL: (210) 452-4895

PROJECT DESCRIPTION:

PROJECT:

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	_
	_
SHEET TITLE	_
OVERALL FLOOR	

PLAN AT ADDITIONS & BUILDING SECTION

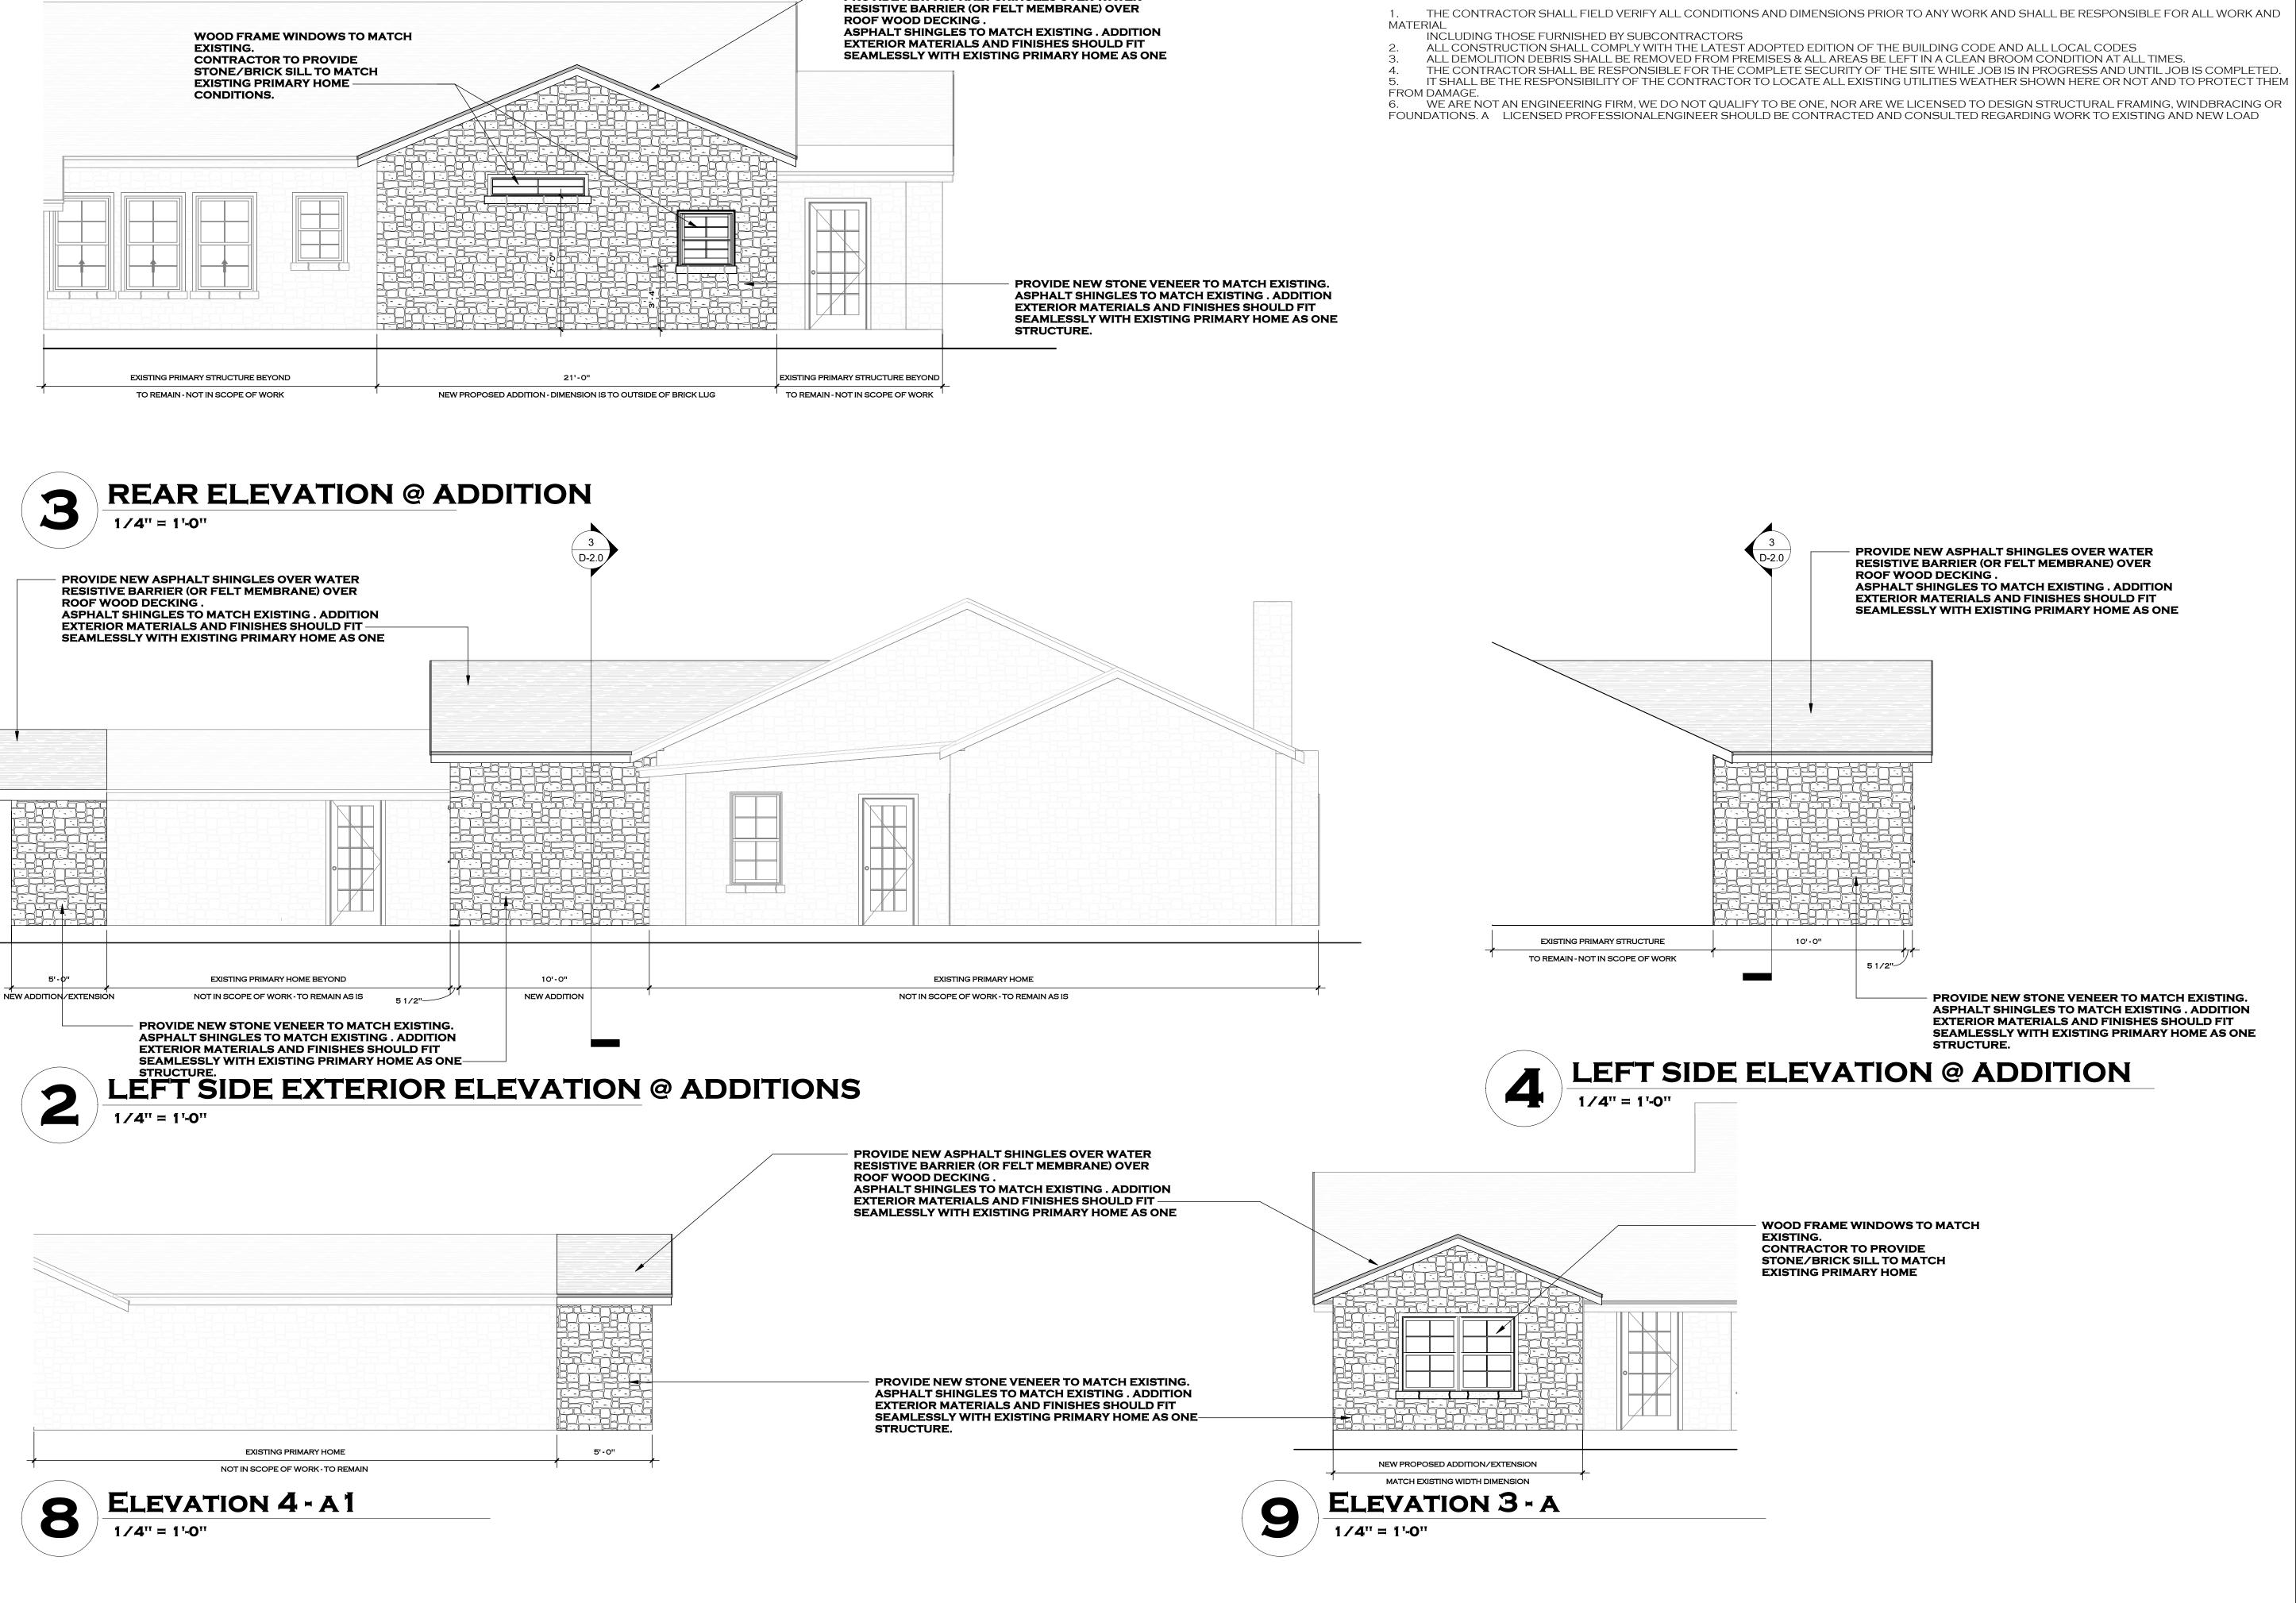
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REVISIONS:

PROJECT STATUS

CHECKED BY. SHEET NUMBER



PROVIDE NEW ASPHALT SHINGLES OVER WATER

GENERAL NOTES



TEL: (210) 452-4895

PROJECT DESCRIPTION:

PROJECT:

W RESIDENTIA ADDITION

REVISIONS:

PROJECT STATUS

SHEET TITLE

EXTERIOR

ELEVATIONS @ ADDITION

DATE

PROJECT NO.

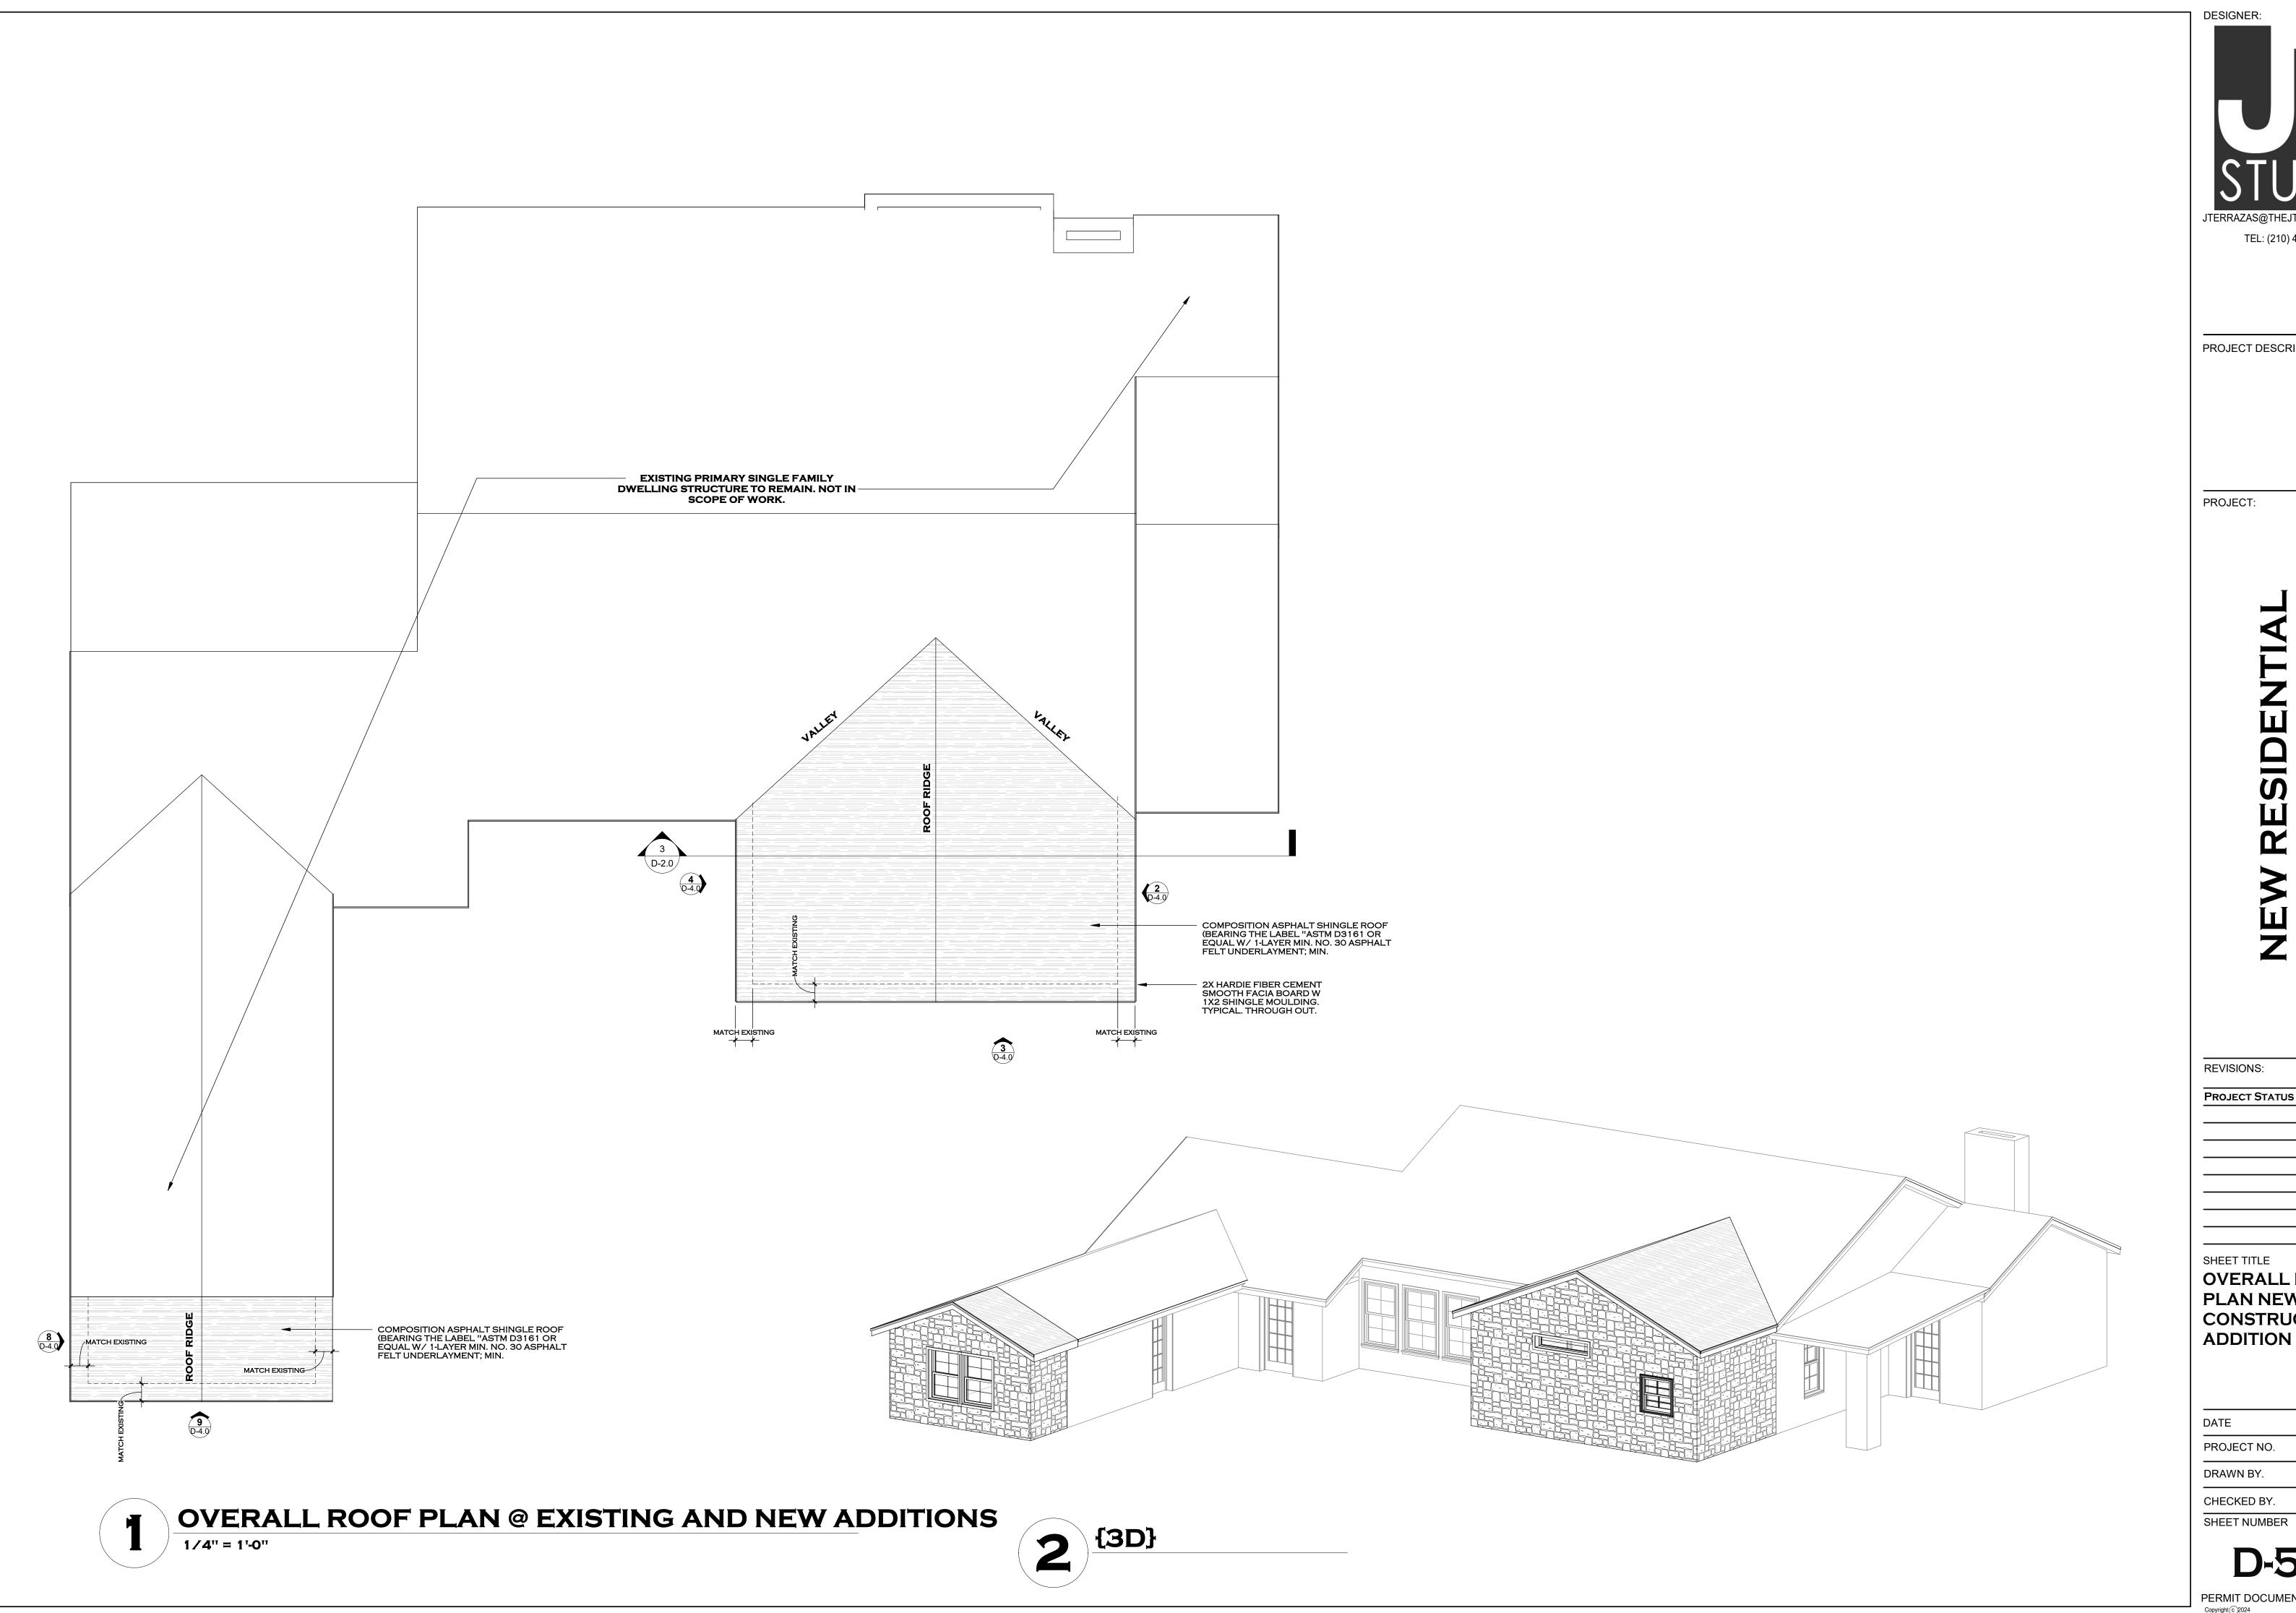
DRAWN BY.

CHECKED BY.
SHEET NUMBER

D-A

PERMIT DOCUMENTS

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PROJECT DESCRIPTION:

PROJECT:

REVISIONS:

PROJECT STATUS

SHEET TITLE

OVERALL ROOF PLAN NEW CONSTRUCTION @ **ADDITION**

PROJECT NO.

DRAWN BY.

CHECKED BY.

D-5.0